

PROJECT: DCSD 2021 CIP - Parker Package	CONTRACTOR: Mark Young Construction
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DATE: July 23, 2021	CHANGE ORDER #:	14	
DATE: JULY 23, 2021	CHANGE ORDER #:	14	

This contract shall be changed as follows:

CHANGES:

1. PLN COR #21 - CCD #7 Structural Steel Revisions

\$111,493.00

TOTAL CHANGE ORDER:

\$111,493.00

By signing below the contractor acknowledges acceptance of this change order as full compensation to the Contractor for all costs related in any way to this work and its effect on other work already contracted for.

CONTRACT STATUS:

Original Contract Sum	\$18,343,732.00
Previous Change Orders	\$416,577.00
Current Contract	\$18,760,309.00
This Change Order	\$111,493.00
NEW CONTRACT TOTAL	\$18,871,802.00
tract time will be extended by	0

2

The Contract time will be extended by0the date of this Change Order is9/4/2021

NOT VALID until signed by the Contractor, Architect, and Owner, and approved by the School District's Board of Education (if applicable).

LKA Partners	Mark Young Construction	Douglas County School District
Consultant ugfl	Contractor	Sec
By 8/3/2021	By 8/3/2021	Ву
Date	Date	Date



Vía Email: <u>ben.froemming@nv5.com</u>

July 23, 2021

Douglas County Schools 2021 Parker Package Pine Lane North NV5 Attn: Ben Froemming 2650 18th St. Suite 202 Denver, Colorado 80211

Project: Douglas County Schools 2021 Parker Package Pine Lane North

Project Number: 211706

Subject: Change Order Request #21 – CCD #7 Structural Steel Revisions

Dear Mr. Froemming,

Attached you will find the pricing and backup for the additional work directed in CCD #7 and associated work for additional Structural steel reinforcing. Pursuant to the subject matter above, Mark Young Construction Inc. is providing the cost and associated backup to incorporate the following changes as specified in the attached documents. This pricing is valid for 10 business days, acceptance after that time may require the cost and time to be revisited.

The cost to incorporate these changes are: \$111,493.00 Add of: One Hundred Eleven Thousand Four Hundred Ninety-Three Dollars and Zero Cents.

Please review and contact us with any questions or if you need additional information.

Sincerely,

Brian Kennedy Project Engineer 303-710-6088 <u>bkennedy@markyoungconstruction.com</u> Attachments: cost summary, subcontractor backup, CCD #7. cc: ben.froemming@nv5.com 211706-F-1.2 COR #21

District response, please sign as appropriate:



Approved, Proceed as submitted



Rejected, Do not proceed, provide comments



Other, Do not proceed, provide comments

Project Manager Signature

Date

MARK YOUNG CONSTRUCTION, INC. PROJECT NAME: DCSD Pine Lane North PROJECT NUMBER: 211706 CHANGE ORDER REQUEST SUMMARY

CHANGE ORDER NO.21

CHANGE ORDE	ER REQUEST SUMMARY	CCD#7, S	ructural Revisions
COST CODES	ACTIVITY DESCRIPTION	AMOUNT	TOTALS
	MYC LABOR		
	MYC Clean up ~ 12 Hours Demo Cap above casework ~ 2 Hours Floor Protection Repair ~ 32 Hours Repair Wood Cap ~8 Hours	\$ 540 \$ 90 \$ 1,440 \$ 360	
	MYC LABOR TOTAL		\$ 2,43
	Repair wood Cap Floor protection (Ram Board & box of Tape)	\$ 100 \$ 250	
	MYC MATERIAL TOTAL		\$ 35
	MYC EQUIPMENT		
	MYC EQUIPMENT TOTAL		\$ -
	SUBTOTAL SMALL TOOLS PAYROLL TAXES & INSURANCE GENERAL CLEANUP DELIVERY DRAWINGS & SPECS	\$ - \$ 1,045 \$ - \$ - \$ -	\$ 2,78
	SUBTOTAL		\$ 3,82
	MYC OVERHEAD & PROFIT @ 3.0%		\$ 11:
	SUBTOTAL MYC WORK		\$ 3,94

MARK YOUNG CONSTRUCTION, INC. PROJECT NAME: DCSD Pine Lane North PROJECT NUMBER: 211706 CHANGE ORDER REQUEST SUMMARY

CHANGE ORDER NO.21

CCD#7, Structural Revisions	
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COST CODES	ACTIVITY DESCRIPTION		AMOUNT		TOTALS
	SUBCONTRACTOR COSTS				
	<u>Allen's Builders</u> Steel reinforcing @ Grid A, E, & L; Add for E&L. Credit for A. Shop Drawing changes and CCD #7.	\$	83,339.70		
	<u>Adobe Construction</u> Framing & Drywall, Adhered Ceiling Install; @ E & L line	\$	6,798.50		
	Engineered Demolition Removal of drywall systems @ E & L line Removal of drywall high loft L line Wayne's Electric Remove and Re-install conduit L line	\$ \$ \$	1,480 2,950 257		
	Braconier Remove and Placeback Hot and Cold water piping in Kitchen	э \$	1,041		
	<u>Brighten Up</u> Price to paint new cap in band room	\$	175		
	SUBCONTRACTOR TOTAL			\$	96,041.20
	MYC OVERHEAD & PROFIT @ 10.0%	\$	9,605.00		
	SUBTOTAL	<u> </u>		\$ \$	105,646.20
	SUBTOTAL (DIRECT COSTS) BUILDER'S RISK INSURANCE16% LIABILITY INSURANCE55% MYC BOND - 1.03% SUBCONTRACTOR BOND - N/A PERMIT FEES - N/A	\$ \$ \$ \$ \$	175 603 1,129 - -	>	109,586.20
	SALES TAX - N/A CONTRACTOR CONTINGENCY - N/A PROPOSED CHANGE TOTAL	\$ \$	-	\$	111,493

Allen Builders

Phone:719-301-0669

Change Order Proposal

To: MYC - Pine Lane Intermediate Elem. From: Jerred Young

Name: Rich Jacobs

Date: 7/10/2021

Change # 6 (RFI#26)

Scope: Add L3x3x1/2 with full length cut heel, add plates along gridline E and L.

Material:

E Line - 240 Lf L3x3x1/2= \$2165.76 L Line - 280 Lf L3x3x1/2 = \$2562.72

Total= \$4728.48

Shop Labor/Paint:

E Line - 18 hrs @ \$75 per hour = \$1350.00 L Line - 21 hrs @ \$75 per hour = \$1575.00 Shop Primer - 520 Lf angle = \$472.85

Total= \$3397.85

Field labor and equipment:

E Line - 168 hrs @ \$100 per hour = \$16800.00 L Line - 196 hrs @ \$100 per hour = \$19600.00 Equipment- 2 lifts @ \$296 per week x 2 weeks= \$1184.00

Total= \$37584.00

Sub Total= \$45,237.48 10% OHP = \$4,523.75

Grand Total CO #6 = \$49,761.23

Exclusions: As discussed, not responsible for distortion due to all of the heat being applied to only one side of the beam locations per EOR detail. EOR doubled the plate locations shown on drawings along grid L.

CCD7 rev. 1 CO#7 Breakout

		T	-						
	Α	В	C	D	E	F	G	Н	I
1		Qty	LF weld	Material Cost	Shop labor	field Labor hrs	Field Labor cost	Shop Primer	Total
2	B/C- Line changes								
3	Add L3x3x3/8 Top/Bot chord of both sides @ 104C1	8	8	\$138.24	х	20	\$2,000.00	x	\$2,138.24
4	Add L3x3x3/8 Top/Bot chord of both sides @ 104C2	8	8	\$138.24	х	20	\$2,000.00	x	\$2,138.24
5	D-Line changes								
6	Add L3x3x3/8 Top/Bot chord of both sides @ 105C1	4	8	\$138.24	х	10	\$1,000.00	x	\$1,138.24
7									
8	F/H-Line changes								
9	Add L3x3x3/8 Top/Bot chord of both sides @ 105C2	8	8	\$138.24	х	20	\$2,000.00	x	\$2,138.24
10	Add L3x3x3/8 Top/Bot chord of both sides @ 105C3	8	8	\$138.24	х	20	\$2,000.00	X	\$2,138.24
11	Add L3x3x3/8 Top/Bot chord of both sides @ 106C3	8	8	\$138.24	х	20	\$2,000.00	X	\$2,138.24
12									
	G-Line changes								
14	Add L3x3x3/8 Top/Bot chord of both sides @ 106C1	4	8	\$138.24	х	10	\$1,000.00	X	\$1,138.24
15	Add L3x3x3/8 Top/Bot chord of both sides @ 106C2	4	8	\$138.24	х	10	\$1,000.00	x	\$1,138.24
16	Add L3x3x3/8 Top/Bot chord of both sides @ 102C2	4	8	\$138.24	х	10	\$1,000.00	x	\$1,138.24
17									
	J-Line changes								
19	Add L3x3x3/8 Top/Bot chord of both sides @ 107C3	4	8	\$138.24	х	10	\$1,000.00	x	\$1,138.24
20	Add L3x3x3/8 Top/Bot chord of both sides @ 103C1	4	8	\$138.24	х	10	\$1,000.00	x	\$1,138.24
21	Add L3x3x3/8 Top/Bot chord of both sides @ 103C2	4	8	\$138.24	х	10	\$1,000.00	x	\$1,138.24
22									
23	K-line Changes								
24	Add 1/2 plate @ 117C1	1	2.5	\$15.32	х	2.5	\$250.00	x	\$265.32
25	Add L3x3x3/8 Top/Bot chord of south side @ 117C1	2	4	\$69.12	х	5	\$500.00	x	\$569.12
26	Add L3x3x5/16 angle @ 117C1	4	8	\$117.12	х	10	\$1,000.00	x	\$1,117.12
27	Remove 2 web members @ 119C1 (note D)	2	cut	х	х	5	\$500.00	x	\$500.00
28	Add L3x3x3/8 Top/Bot chord of both sides @ 119C1	4	8	\$138.24	х	10	\$1,000.00	x	\$1,138.24
29	Add L2-1/2x2-1/2x3/8 vertical web angles @ 119C1 (note G)	4	8	\$113.28	Х	10	\$1,000.00	x	\$1,113.28
30	Add L2-1/2x2-1/2x1/4 sister web angles @ 102C3 (note C)	4	6	\$78.72	х	10	\$1,000.00	x	\$1,078.72
31	Add L2-1/2x2-1/2x3/8 vertical web angles @ 102C3 (note G)	4	8	\$113.28	х	10	\$1,000.00	x	\$1,113.28
32	Add L2-1/2x2-1/2x3/8 vertical web angles @ 119C2 (note G)	4	8	\$113.28	х	10	\$1,000.00	x	\$1,113.28
33	Remove 2 web members @ 119C2 (note D)	2	cut	х	х	5	\$500.00	x	\$500.00
34	Remove 1 web members @ 103C3 (note D)	1	cut	x	х	2.5	\$250.00	x	\$250.00
-	Add L2-1/2x2-1/2x3/8 web angle @ 103C3 (note B)	2	4	\$56.64	х	5	\$500.00	x	\$556.64
36	- · ·								
37	Totals	102	152.5	\$2,473.88	0	255	\$25,500.00	\$800.00	\$800
38							· ·		-
39	Equipment		# Weeks	Cost per Week					
40		3	2	\$292.00					\$1,752.00
41									-
42								Sub Total	\$30,525.88
43								10% OHP	\$3,052.59
44									
45								Grand Total	\$33,578.47

	CO#6 breakout (RFI#26)							
	qty	LF weld	Material Cost	Shop labor	Field Labor hrs	Field Labor cost	Shop Primer	Tot
Added L3x3x1/2 w/cut heel								
E-Line (remove 2 bolt at top chord each ext. joist location for install)	240	240	\$2,165.76	\$1,350.00	168	\$16,800.00	\$216.58	\$20,3 1
L-Line (remove 2 bolt at top chord each ext. joist location for install)	280	280	\$2,562.72	\$1,575.00	196	\$19,600.00	\$256.27	\$23,73
Totals	520 Lf	520 Lf	\$4,728.48	\$2,925.00	364	\$36,400.00	\$472.85	
Equipment (2 lifts for two weeks)	2		\$296 per week					\$1,:

Sub Total \$4 10% OHP 5

Grand Total \$4

Total

D,315.76 3,737.72

1,184.00

\$45,237.48 \$4,523.75

\$49,761.23



Proposal

Personal - (720) 633-0441 Office - (303) 388-3639 Fax - (303)388-4378

Project Name: PINE LANE RFI #26 Proposal

Proposal Submitted To: Mark Young Construction

Street: 7200 Miller Pl

City, State, Zip: Frederick Co. 80504

Phone: 3023-776-1449

Date: 7/13/21

We hereby submit specifications and estimates for:

-FRAME/DRYWALL:

Repair any framing in High loft ceiling and drywall, in two sections app 200 sq ft, grid L, repair all framing in corridor and bathroom 158 grid E app 120Sq ft Including drywall, Finish on bathroom ceiling to be level 4, Replace adhesive ceiling tiles app 32 Sq Ft,

MATERIALS:

Steel studs, type x GB and Drywall Mud,	
adhesive ceiling tiles1,25	50.00.

LABOR:

Framing and drywall installation 40HR 2 workers	2,600.00.
Drywall finisher 32HR	.2,080.00.
Ceiling installation 8HR	520.00.

We propose hereby to furnish material and labor – complete in accordance with specifications below, for the sum of: 6,798.50

All material is guaranteed to be as specified. All work is to be completed in a workmanlike manner according to standard practices. Any alteration or deviation from specifications below involving extra costs will be executed only upon written orders and will become an extra charge over and above the estimate. All agreements contingent upon strikes, accidents or delays beyond our control. Owner to carry fire, tornado and other necessary insurance.

Note: This proposal may be withdrawn by us if not accepted within <u>10</u> days.

Authorized Signature: Miguel Ramos

Owner Acceptance:

ALL MATERIALS, AND LABOR IS INCLUDED ON THIS PROPOSAL

Acceptance of Proposal – the above prices, specifications and conditions are satisfactory and are hereby accepted. You are authorized to do the work as specified.

Payment will be made as outlined above.

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Date:_



Proposal for Selective Demolition

PLN CCD #7

6485 E. Ponderosa Dr. Parker, CO 80138 7/14/2021

PREPARED FOR: MYC

Attn: Brian Kennedy

Via email: bkennedy@markyoungconstruction.com

SCOPE OF WORK: Demo and dispose of:

- Grid L High Loft Ceiling
- Haul Away/Recycle Debris
- (1) Mobilization

BASE BID: \$2,950.00

Demo and dispose of:

- Corridor/Bathroom Ceilings
- Haul Away/Recycle Debris
- (1) Mobilization

BASE BID: \$1,480.00

ALTERNATES: • N/A

QUALIFICATIONS: • Day work is assumed. Weekend work excluded

• Only demolition work listed in the scope of work above is included

EXCLUSIONS: • Shoring and/or Bracing

- Lintel Installation
- Layout
- Structural Work of Any Kind
- Protection of Existing Conditions
- Permits
- Floor prep or glue removal, and wall prep
- M.E.P. demo or haul-away
- Disconnect or capping of any existing utilities
- Sampling, testing, removal and/or disposal of hazardous or potentially contaminated materials. Such materials include, but are not limited to, asbestos containing materials, chemicals, refrigerants, PCBs, and lead-based paint.





Respectfully submitted,

Ben Emanuelson

Estimator – Project Manager | Engineered Demolition, Inc. mobile 303-880-1141 | bemanuelson@engineereddemo.com





CHANGE ORDER

WAYNE'S ELECTRIC INC.

2101 Weld County road 27 Fort Lupton,Colorado 80621 PHONE: 659-7481 FAX: 654-0877

		MARK YOUNG CONSTRUCTION DUANE KRUEGER PINE LANE NORTH			
	DATE:	7/16/2021	CHANGE ORDER N	UMBER:	COULUMN LINE L
WE HE	REBY AGREE TO MA PLEASE SEE ATTA	AKE THE CHANGE(S) SPECIFIED BI CHED	ELOW		
		R BECOMES PART OF AND IN CON			
WEAG	REE TO MAKE THE	CHANGE(S) SPECIFIED ABOVE AT	THIS PRICE:	ADD	\$257.00
				1	
DATE:	July 16, 202	21			
AUTHO	RIZED SIGNATURE	CONTRACTOR):			
1					
1	EPTED: DF ACCEPTANCE:				
SIGNA	TURE(OWNER):				



CO-0011: COLUMN LINE L co:

Summary by Item Number

Vendor: TRADE/3-COL				Labor Level: LABO			16 Jul 2021	12:28:07		
Item # Size	Description	Q/M	Quantity	U/M	Mat Unit	Mat Result	Lab Unit	Lab Result	Quo Unit	Quo Resi
380053 1/2	REMOVE EXISTING CONDUIT	М	20.00	FT	0.0000	0.00	0.0300	0.60	0.0000	0.0
380069 12	EXISTING WIRE TO PULL OUT	М	120.00	FT	0.0000	0.00	0.0060	0.72	0.0000	0.0
380094 2 x 4	REMOVE EXISTING FLUORESCENT FIXTURE	М	1.00	EA	0.0000	0.00	0.6000	0.60	0.0000	0.0
380103	REHANG EXISTING FLUORESCENT FIXTURE	М	1.00	EA	0.0000	0.00	0.9000	0.90	0.0000	0.0
	Phase/Group totals:			0.00		2.82		0.0		
				Job totals:		0.00		2.82		0.0

0.00

Grand Material, Quote, Equipment, and Subcontract Total:

Waynes's Electric

2101 Weld County Road 27 Ft. Lupton, CO 80621

Phone: 303-659-7481 Web:

CO: CO-0011: COLUMN LINE L

Change Order Summary

021 12:29:0	16 Jul 2			I: LABOR 2	Vendor: TRADE/3-COL Labor Leve						
XPANDED O&I	emplate: BASIC (E	Bid Te			Tax Rate status: Default Bid Name: BASE BID						
Labor Hrs	SubCon \$	Equip \$	Material \$	Quote \$			Phase	Drawing			
2.82	0.00	0.00	0.00	0.00			FIXTURES				
2.82	0.00	0.00	0.00	0.00	Sheet Totals:						
	0.00	0.00	0.00	0.00	Tax:						
	0.00	t/Equip/Sub):	o Total (Quo/Ma	Sub				Bid Notes:			
	0.00	Sales Tax:			TAX RATES						
0.00	0.00	Sub Total:		0.0000%	Material:						
232.65	Direct Labor \$:			0.0000%	Quote:						
0.00	direct Labor \$:	In		0.0000%	Labor:						
0.00	Labor Escalation:			0.0000%	Equipment:						
0.00	Labor Tax:			0.0000%	Subcontract:						
0.00	Direct Job Costs (0.00%):			0.0000%	Job:						
					MISCELLANEOUS						
232.65	Prime Cost:			86.63	Avg. Lbr. Rate (Cost):						
11.63	d (Avg. 5.00%) :	Overhead		90.96	Avg. Lbr. Rate (Bid):						
244.28	Net Cost:	0 Net Cost:			Total Square Feet:						
				256.50	Cost Per Sq. Ft.:						
12.21	it (Avg. 5.00%):	Profi		232.65	Labor \$ Per Sq. Ft.:						
0.00	Job Tax:			2.82	Labor Hrs Per Sq. Ft.:						
0.00	ond (0.0000%):	В		1.00	Quantity of Units:						
0.00	Lump Sum:			256.50	Cost Per Unit:						
256.50	Selling Price:			0.00%	Calc. Adjustment:						

Phone: 303-659-7481 Web:

Waynes's Electric



DNIER Since 1906 Design build Mechanical construction FABRICATION SERVICE & MAINTENANCE

Date: 7/20/2021

To: Rich Jacobs MYC

Braconier Plumbing and Heating is in receipt of the following document: CCD No. 7 - Domestic Hot and Cold Water Piping R/R

Remove and Replace Domestic Hot and Cold Water Piping

Exclusions: Saw cut concrete removal Insulation

Our price for this change is:

1,041

\$

Please advise on the status of this change at your convenience. Until further notice, we will continue with our contract work.

Sincerely,

Shawn O'Neill Project Manager

Braconier Plumbing and Heating CHANGE ORDER PROPOSAL REQUEST SUMMARY

Date:	7/20/2021						
Project Name:	DCSD PLN						
Contract / Project No.:							
Description of Change	CCD No. 7						

0.0% Sales Tax Rate

15% Overhead & Profit on Self-Performed Work

15% Overhead & Profit on Subcontracted Work

1.16% Payment & Performance Bond Rate:

0% Textura Usage Fee

Braconier Self-Performed Scope	e of Work:	Ν	Aaterial	Mar	hours	
Material & Labor Hours per the .	Attached Takeoff				[
Material & Labor Hours per the .	Attached Equipment Takeoff	\$	75		6	
Material Handling					0	
Non-Working Direct Supervisior	a				0	
Rental Equipment (scissor lift)		\$	-			
Project Management					2	
	Material/Equipment Subtotal:	\$	75			
MATERIAL	Sales Tax:	\$	-			
	Material/Equipment Total:	Ψ		\$	75	
			0			
L L D C D	Labor Manhours: Composite Hourly Wage Rate:		8			
LABOR	\$	102.45				
	Labor Cost Total:			\$	820	
	Braconier Self-Performed Overhead & Profit: Braconier Self-Performed Total:	\$	134			\$ 1,029
3rd Tier Subcontractors:		—				
HVAC Sheetmetal		\$	-			
Mechanical Insulation		\$	-	0		
DDC Temperature Controls	-	\$ \$	-			
Testing, Adjusting, and Balancin		Ð	-			
Floctrical	6					
Electrical Structural Steel Platform	5					
Structural Steel Platform						
	3rd Tier Subcontractor Cost Subtotal:	\$				
Structural Steel Platform						
Structural Steel Platform	3rd Tier Subcontractor Cost Subtotal:	\$				\$ <u> </u>
Structural Steel Platform	3rd Tier Subcontractor Cost Subtotal: Overhead and Profit on Subcontractors: 3rd Tier Subcontractor Cost Total:					\$ - 12
Structural Steel Platform	3rd Tier Subcontractor Cost Subtotal: Overhead and Profit on Subcontractors:					- 12

Description	Quantity	Materials	Tota	l Materials	Labor	Total La	bor
Demo Piping	1	0	\$	-		2	2
Reinstall hot and cold piping	1	0	\$	-		2	2
Misc. Materials	1	75	\$	75	:	1	1
Install new flange	0		\$	-		1	0
Field Invistagation	1		\$	-		1	1
	0		\$	-			0
Total			\$	75			6

Brighten Up Painting and Restoration, LLC 2401 South Downing Street Denver, CO 80210 303-995-6880 info@brightenpainting.com

Bill To:

Job Site:

Change Order

MULTIPLE LOCCATIONS

PARKER, CO 80504

Change Order Number: CO-015

Change Order Date: Jul 21, 2021

Mark Young Construction, Inc. 7200 Miller Place Frederick, CO 80504

Reference: DCSD 2021 Parker - 201547

CAP @ MUSIC ROOM


Description


PLN - PAINT 124

> \$175.00 Total:



Amount 175.00

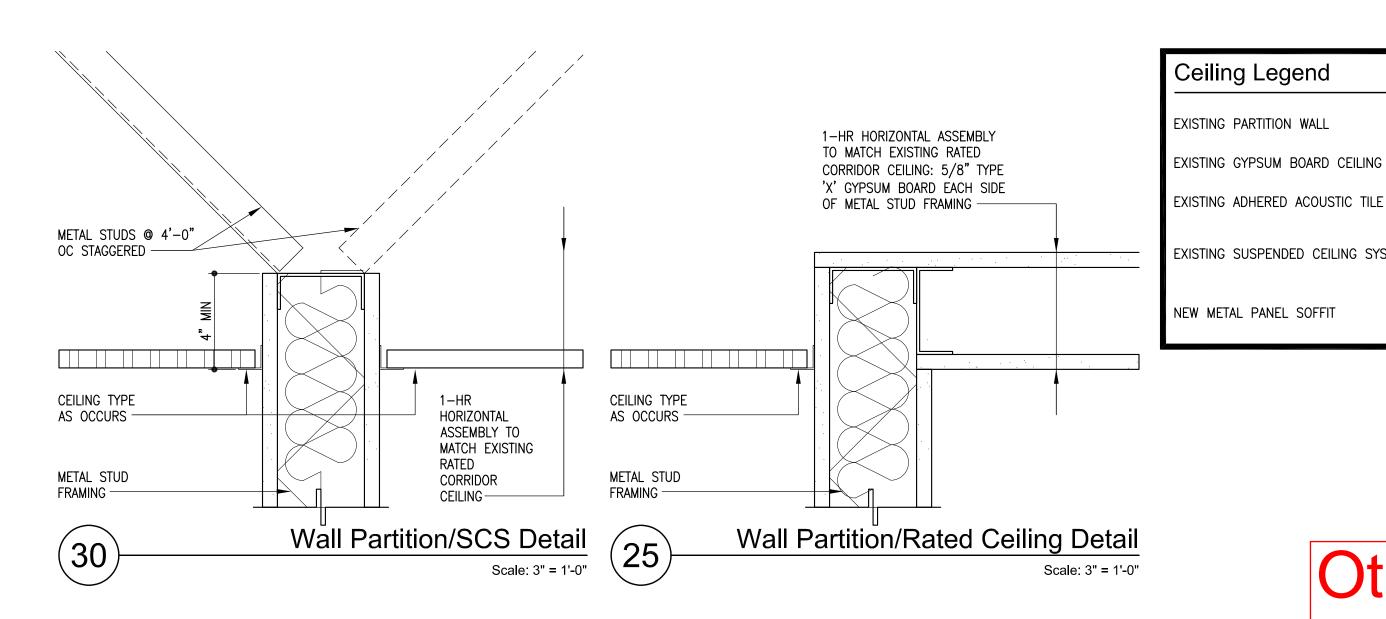

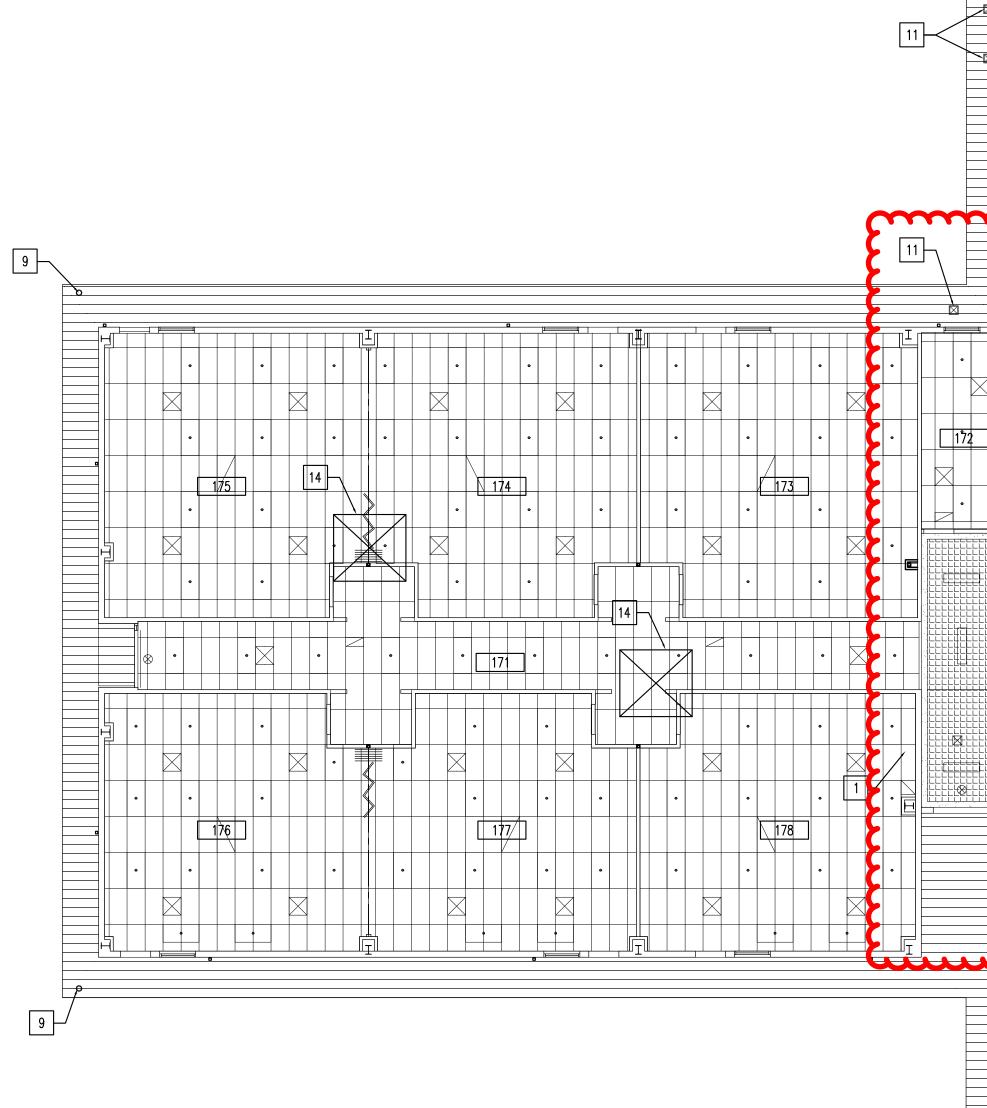

(26)

Ceiling Legend

EXISTING PARTITION WALL

EXISTING ADHERED ACOUSTIC TILE CEILING

EXISTING SUSPENDED CEILING SYSTEM

NEW METAL PANEL SOFFIT


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MECHANICAL GRILLE SURFACE MOUNTED LIGHT FIXTURE RECESSED LIGHT FIXTURE RECESSED CAN LIGHT FIXTURE WALL MOUNTED LIGHT FIXTURE EXIT LIGHT

• $\otimes \otimes$


Other areas affected by Structural steel revisions


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CONSTRUCTION CHANGE DIRECTIVE

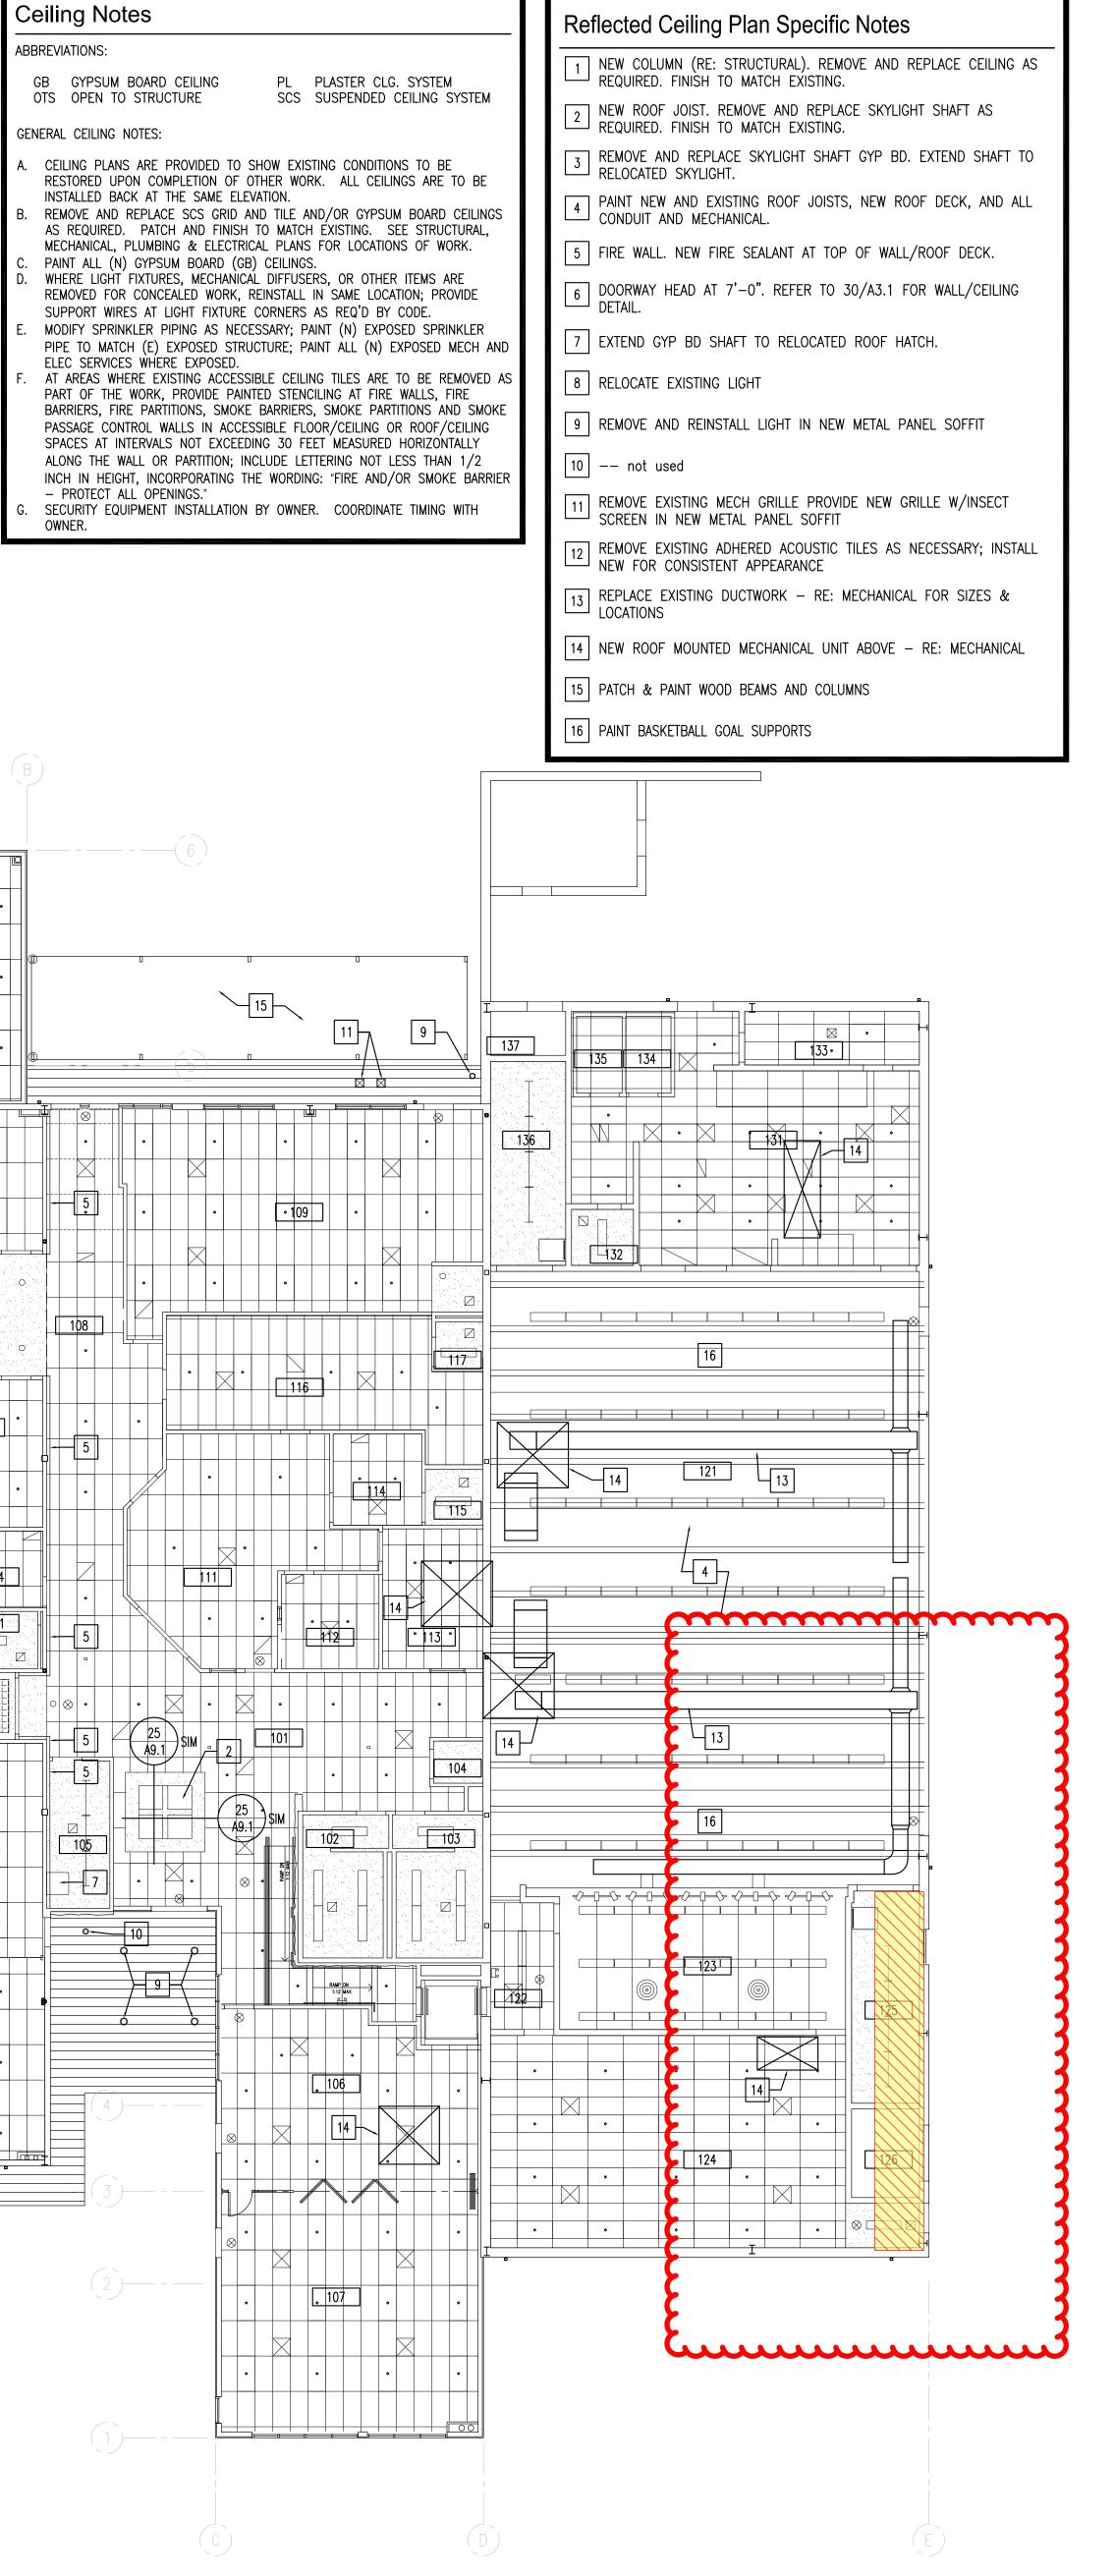

PROJECT:	Pine Lane Elementary School - North Douglas County School District 2021 CIP Projects					
CONTRACTOR:	Mark Young Construction	430 North Tejon Street				
PROJECT NO.:	20-005 Colorado Springs, CO 80903 719/473-8446					
DATE:	07-06-2021					

YOU ARE HEREBY DIRECTED TO MAKE THE CHANGE(S) DESCRIBED BELOW. ALL WORK SHALL BE PERFORMED IN ACCORDANCE WITH THE APPLICABLE PROVISIONS OF THE CURRENT CONTRACT DOCUMENTS, INCLUDING BUT NOT NECESSARILY LIMITED TO THE GENERAL AND SUPPLEMENTARY CONDITIONS OF THE CONTRACT FOR CONSTRUCTION, DRAWINGS, SPECIFICATION SECTIONS, ADDENDA, PREVIOUSLY ISSUED FIELD ORDERS, CONSTRUCTION CHANGE DIRECTIVES, MODIFICATION ORDERS, CHANGE ORDERS, RESPONSES TO REQUESTS FOR INFORMATION AND OTHER DOCUMENTS ORDERING CHANGES TO THE WORK OR INTERPRETING THE CONTRACT DOCUMENTS.

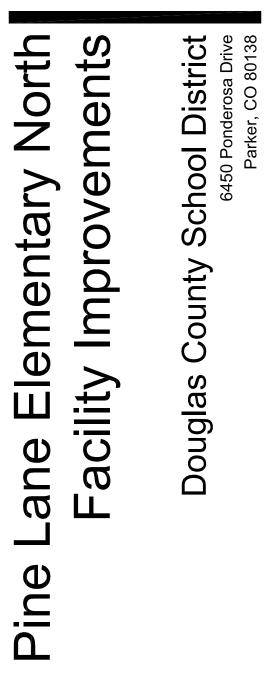CHANGE(S):

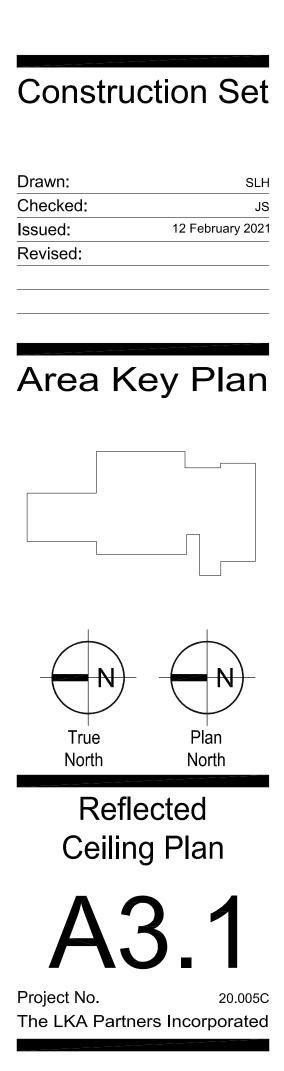1. Work indicated on the drawings including new column. Replace Sheet S4.1, S4.2 and S4.3 with the attached sheets marked 'CCD 7 rev 1 6 July 2021'.

THE TOTAL ___INCREASE ___DECREASE TO THE CONTRACT AMOUNT RESULTING FROM THIS CHANGE SHALL BE:

____ A FIXED SUM OF \$_____

X DETERMINED IN ACCORDANCE WITH THE PROVISIONS OF THE GENERAL AND SUPPLEMENTARY CONDITIONS OF THE CONTRACT FOR CONSTRUCTION. THE CONTRACT AMOUNT WILL BE ADJUSTED ACCORDINGLY IN A FUTURE CHANGE ORDER.

THE CONTRACT TIME SHALL BE:

X UNCHANGED INCREASED BY CALENDAR DAYS

pc: Mykal Hudson, NV5 Duane Krueger, MYC LKA PARTNERS, INC.

Ву _____

ACCEPTED BY CONTRACTOR

APPROVED AND ACCEPTED BY OWNER

Douglas County School District


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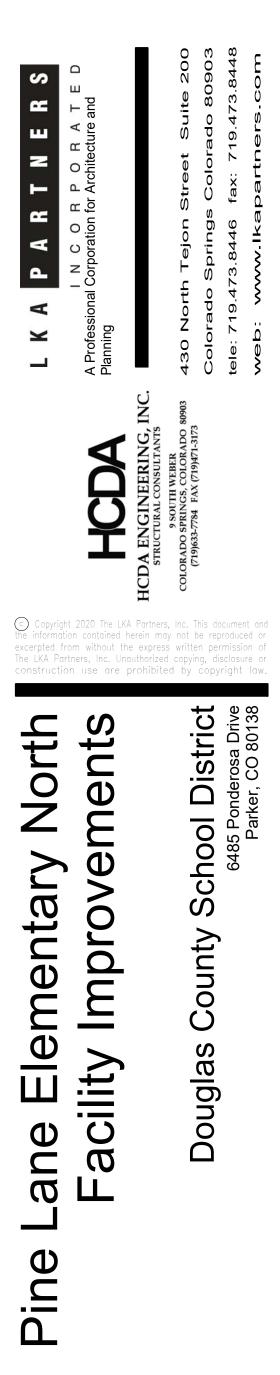
Mark Young Construction.

Date

Date




- EDGE OF NEW JOISTS TO BE LOCATED 8" CLEAR OF EXISTING JOIST EDGE -
- ALTERNATE EACH SIDE OF GIRDER TRUSS, UNLESS NOTED OTHERWISE. ALL NEW SUPPORT COLUMNS SHALL BE HSS4x4x1/4, UNLESS NOTED OTHERWISE. LOCATE NEW COLUMNS IN ARCHITECTURAL PARTITION WALL CENTERLINE WHERE
- APPLICABLE. • SEE 5/S4.2 FOR DECK FASTENING REQUIREMENTS.
- NEW DECK EDGE LOCATED FROM OUTSIDE FACE OF STRUCTURE.
 ALL STEEL JOISTS SHALL BEAR A MINIMUM OF 2 1/2" ON EXISTING GIRDER TRUSS TOP CHORD. EXISTING JOIST TOP CHORD BRIDGING TO BE REMOVED FOR NEW JOIST INSTALLATION. TEMORARLY SUPPORT/BRACE TOP CHORD AT 1/4 POINTS MINIMUM DURING ERECTION.
- PROVIDE JOIST BRIDGING AS REQUIRED PER JOIST MANUFACTURE RECOMMENDATIONS.
- EXISTING JOISTS AT SKY LIGHT LOCATION CENTERLINES SHALL BE REMOVED AND REPLACED WITH NEW JOISTS AT THE SAME LOCATION. • PROVIDE 1 1/2" DEEP, 22-GAUGE (1.5BA) ACOUSTIC ROOF DECK OVER GYMNASIUM AREA.

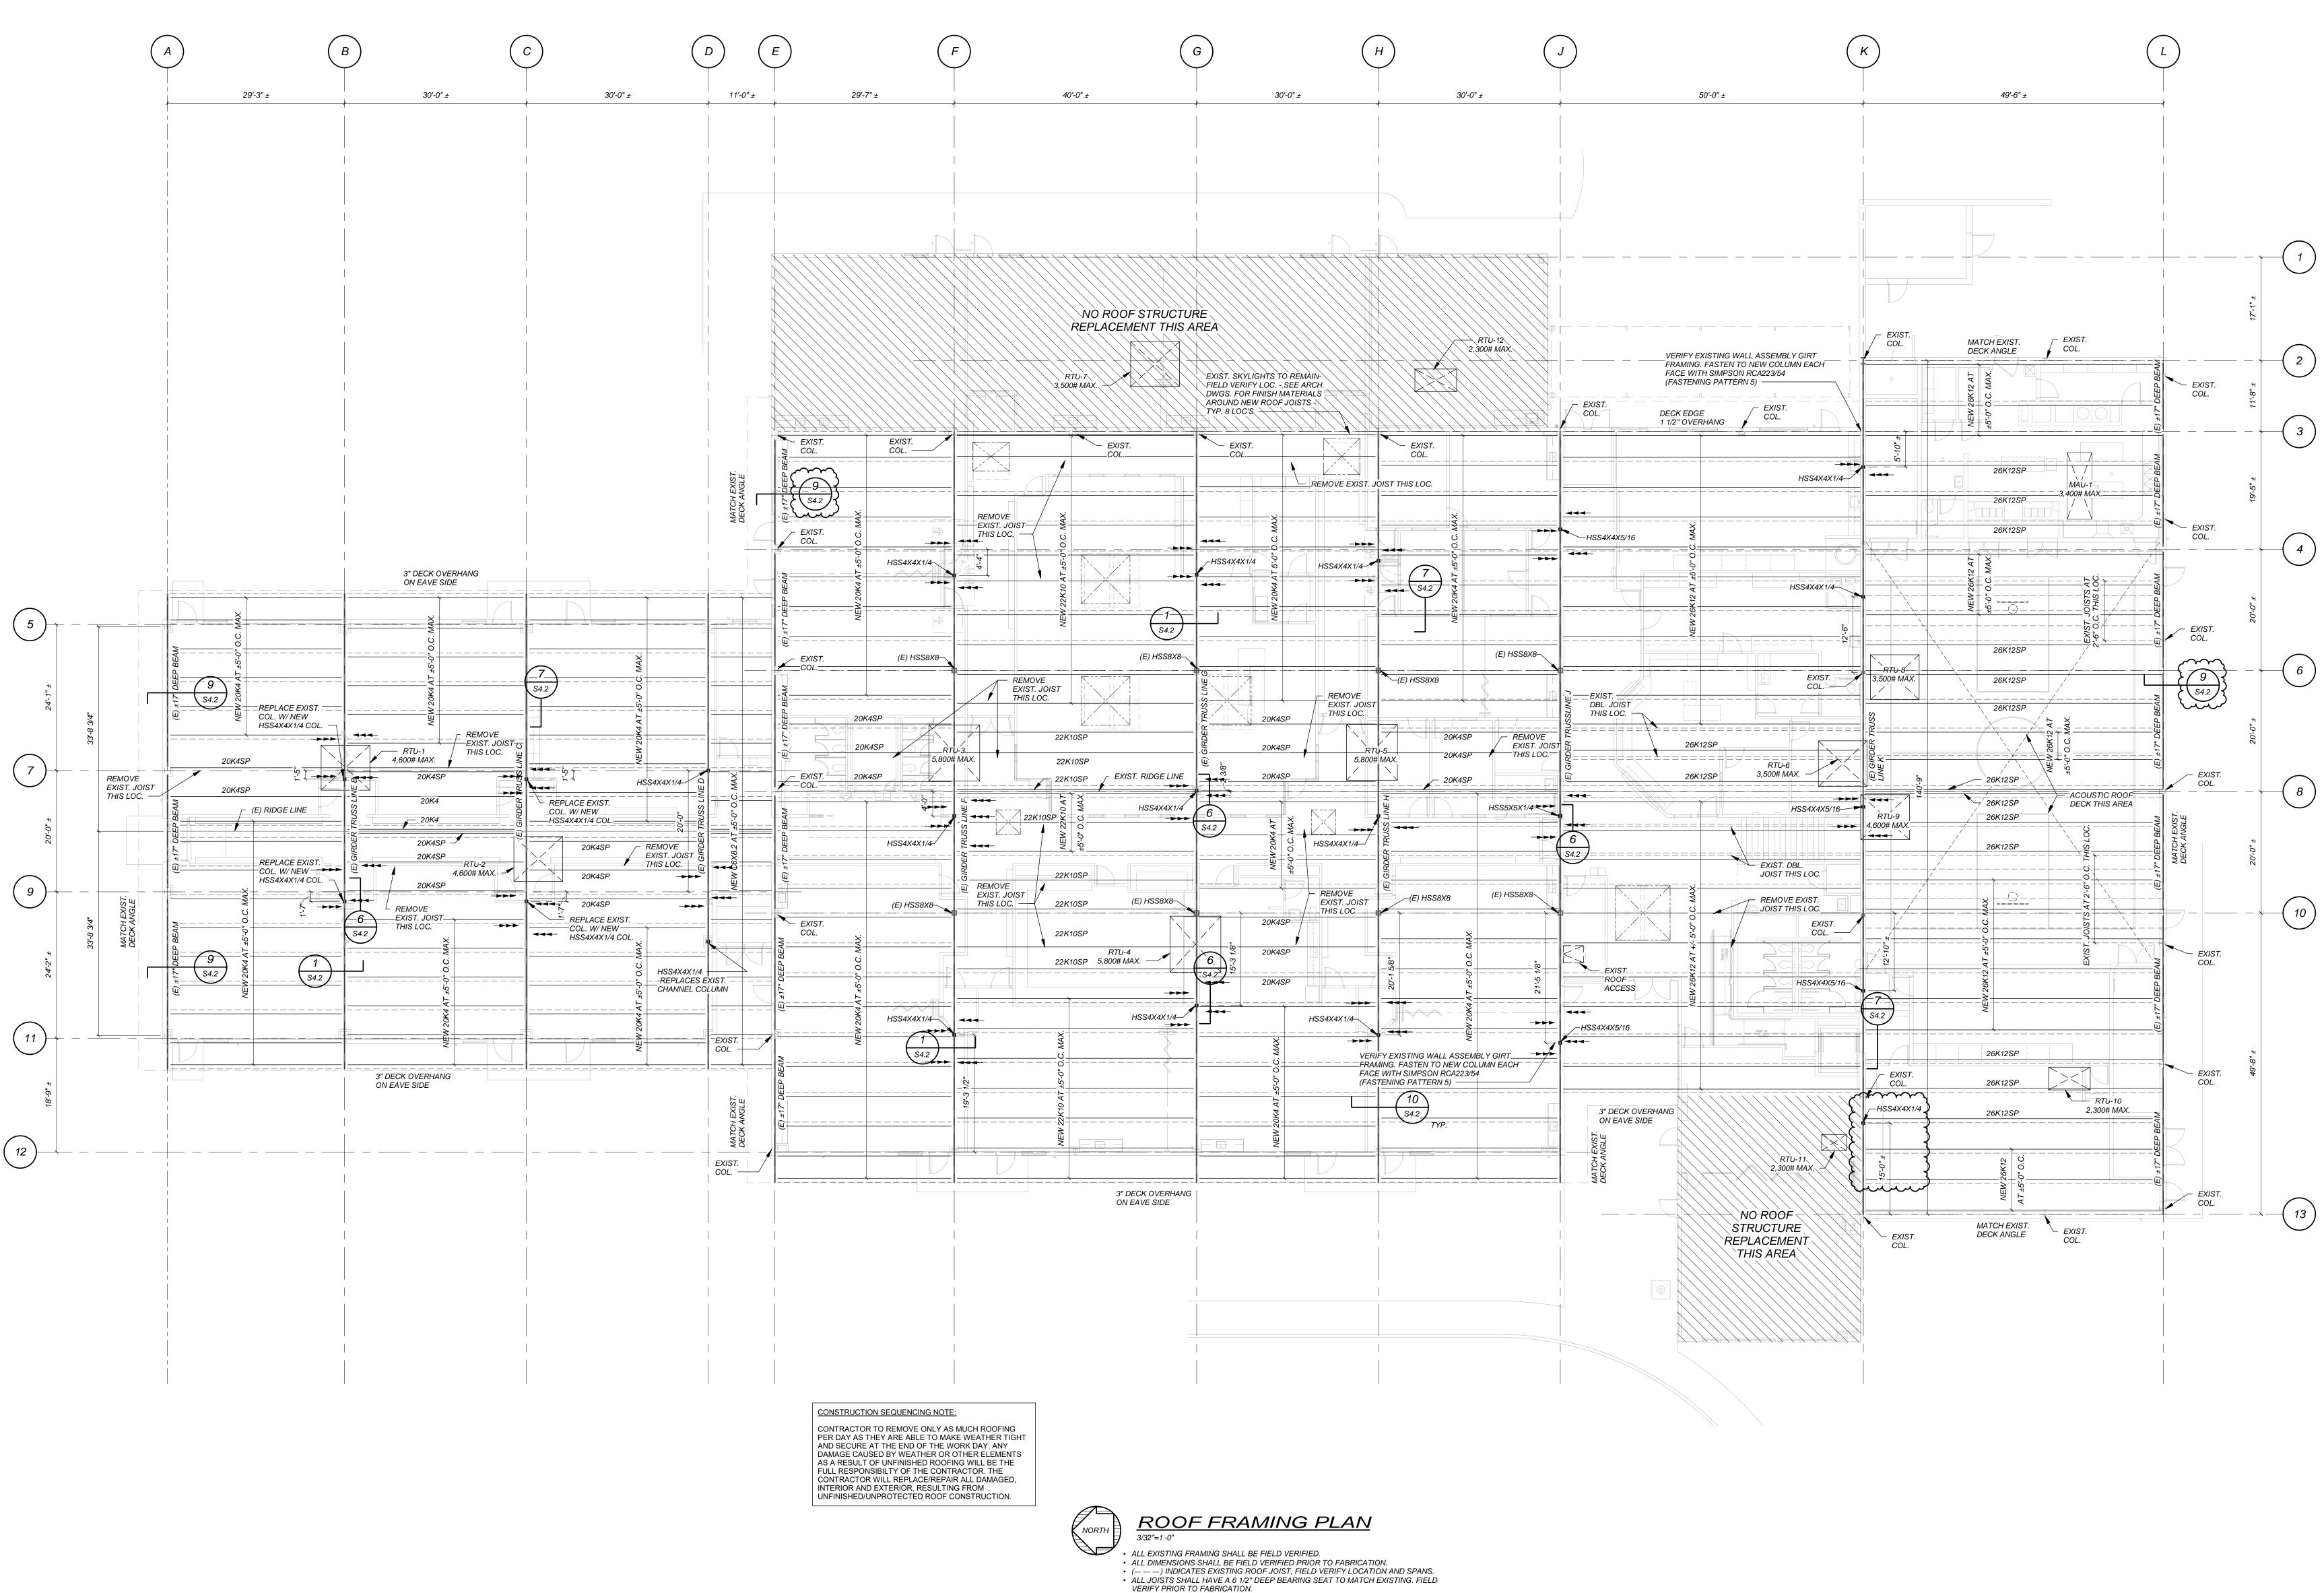



Construction Set

Drawn:	RDB
Checked:	JAK, CBA
Issued:	12 February 2021
Revised:	
CCD4	24 May 2021
CCD7 Rev 1	6 July 2021
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Project No.	20.005C


Project No. 20.005C The LKA Partners Incorporated

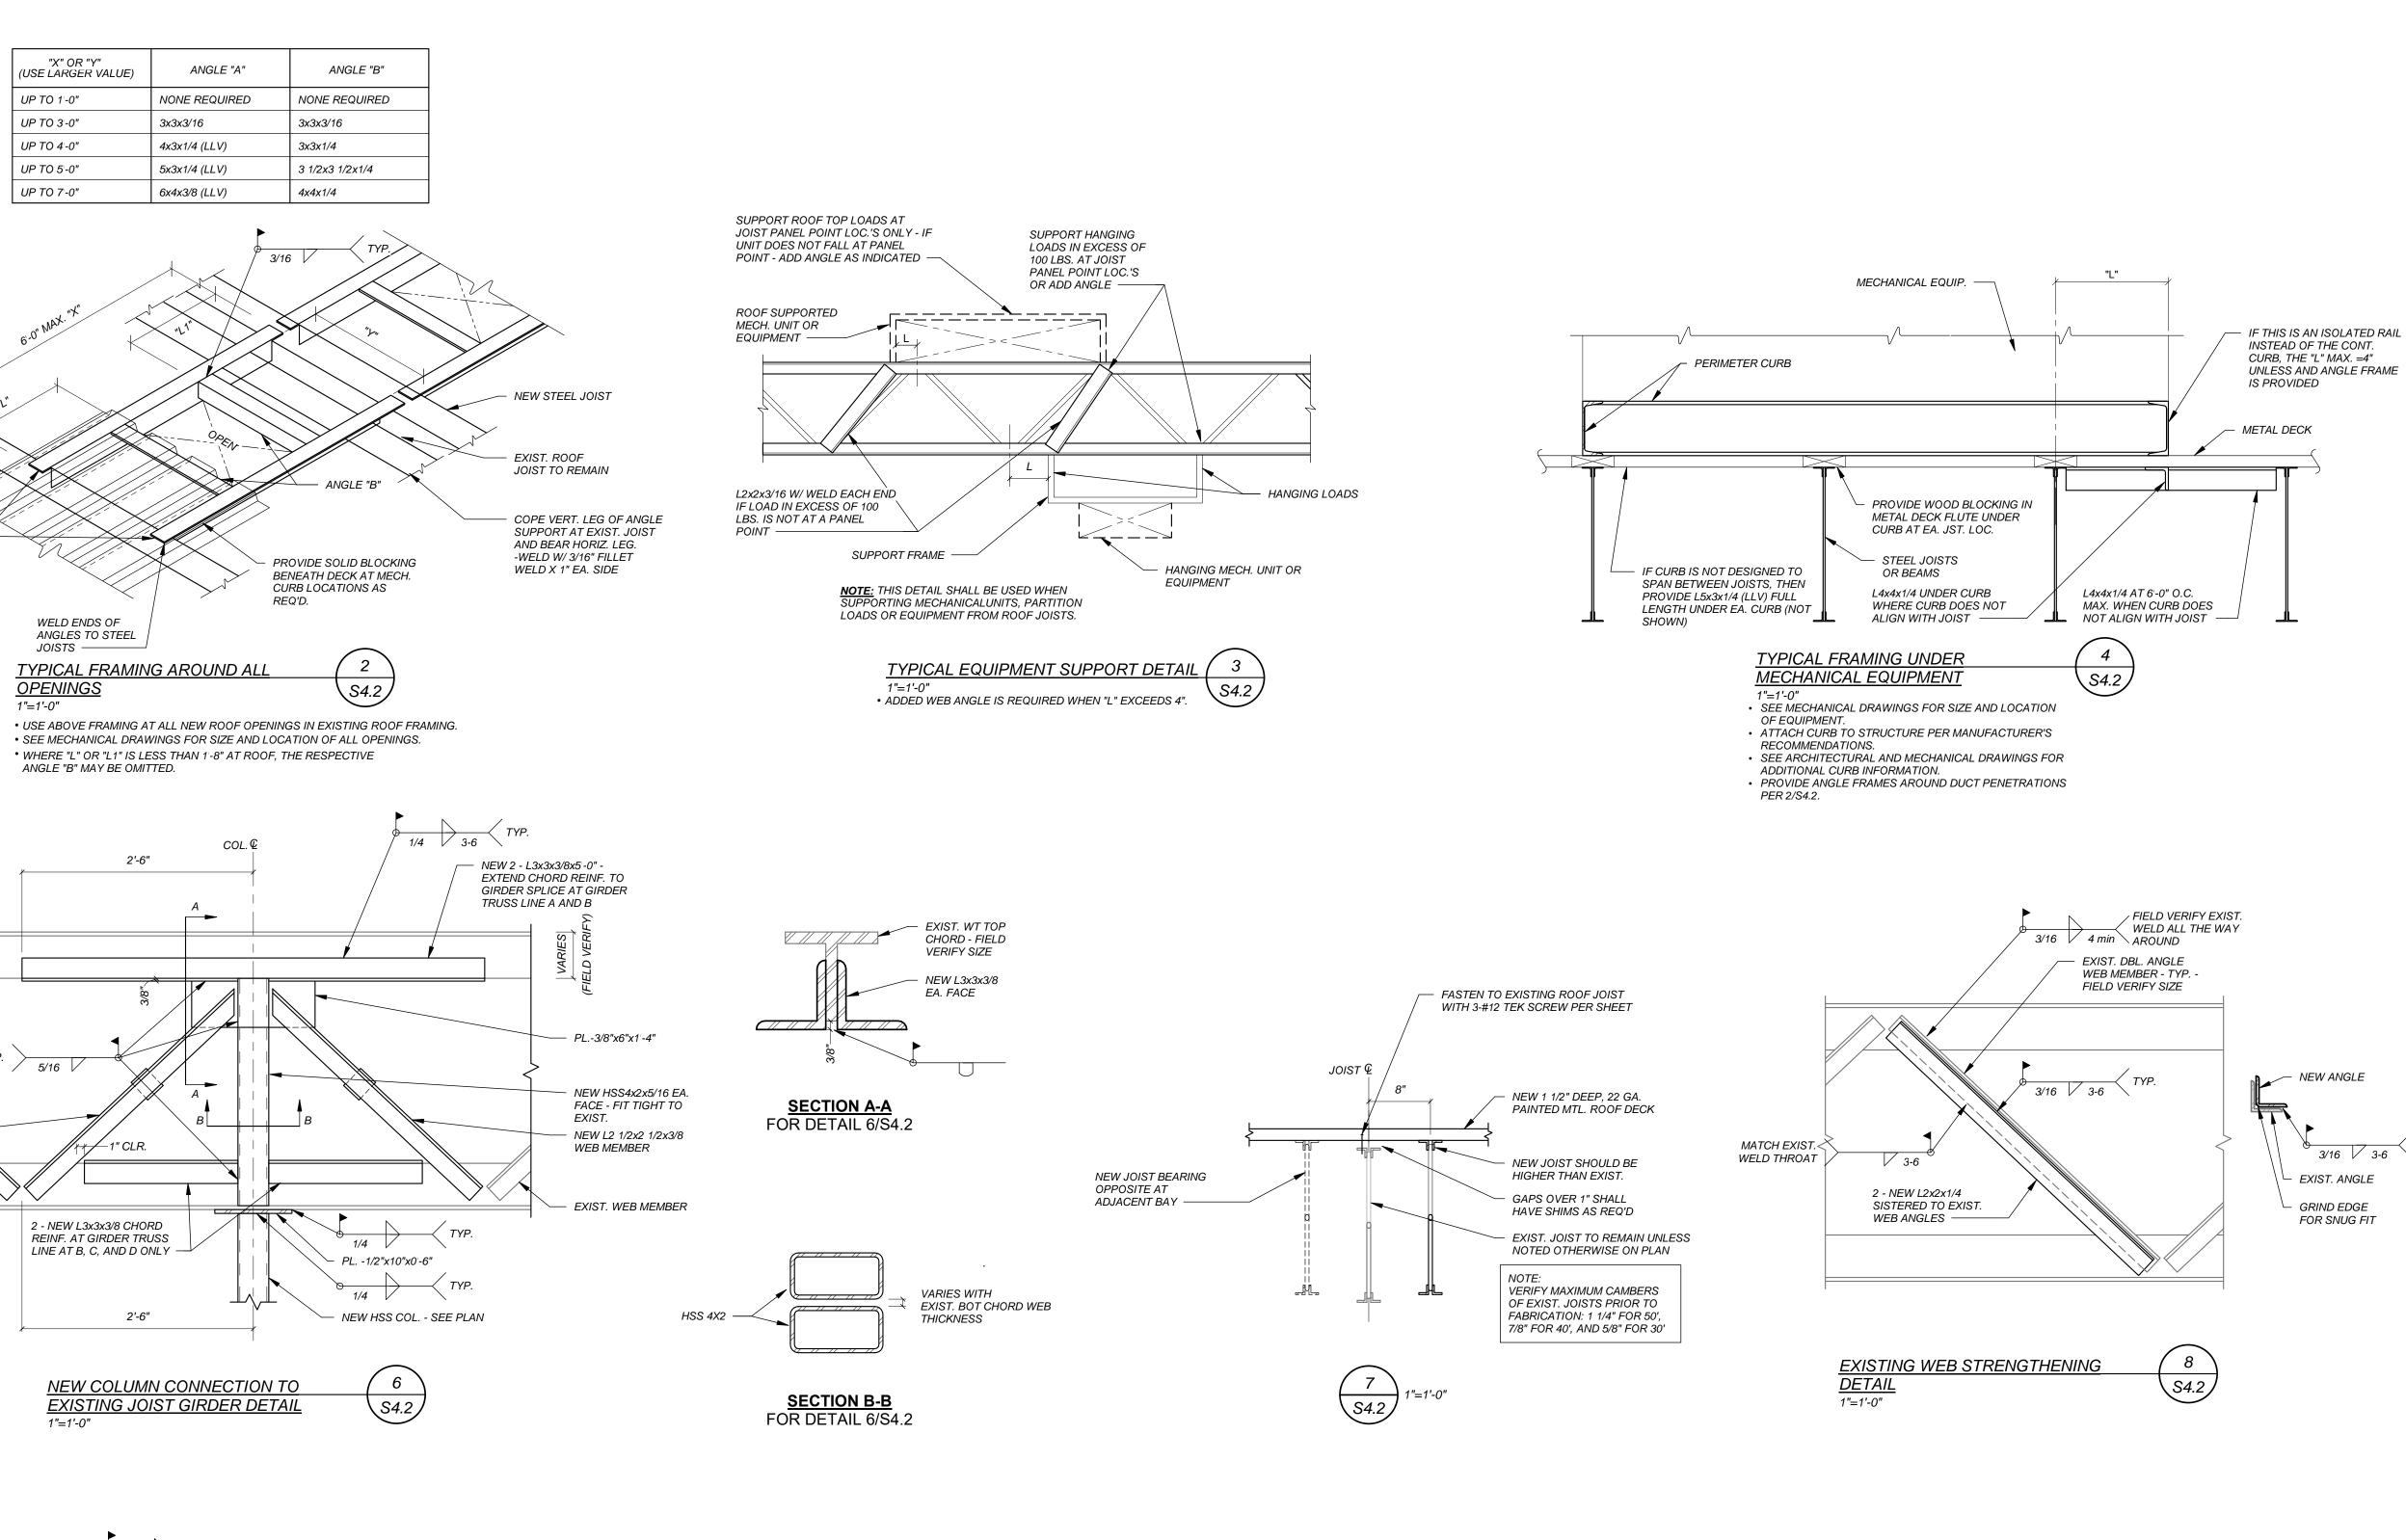

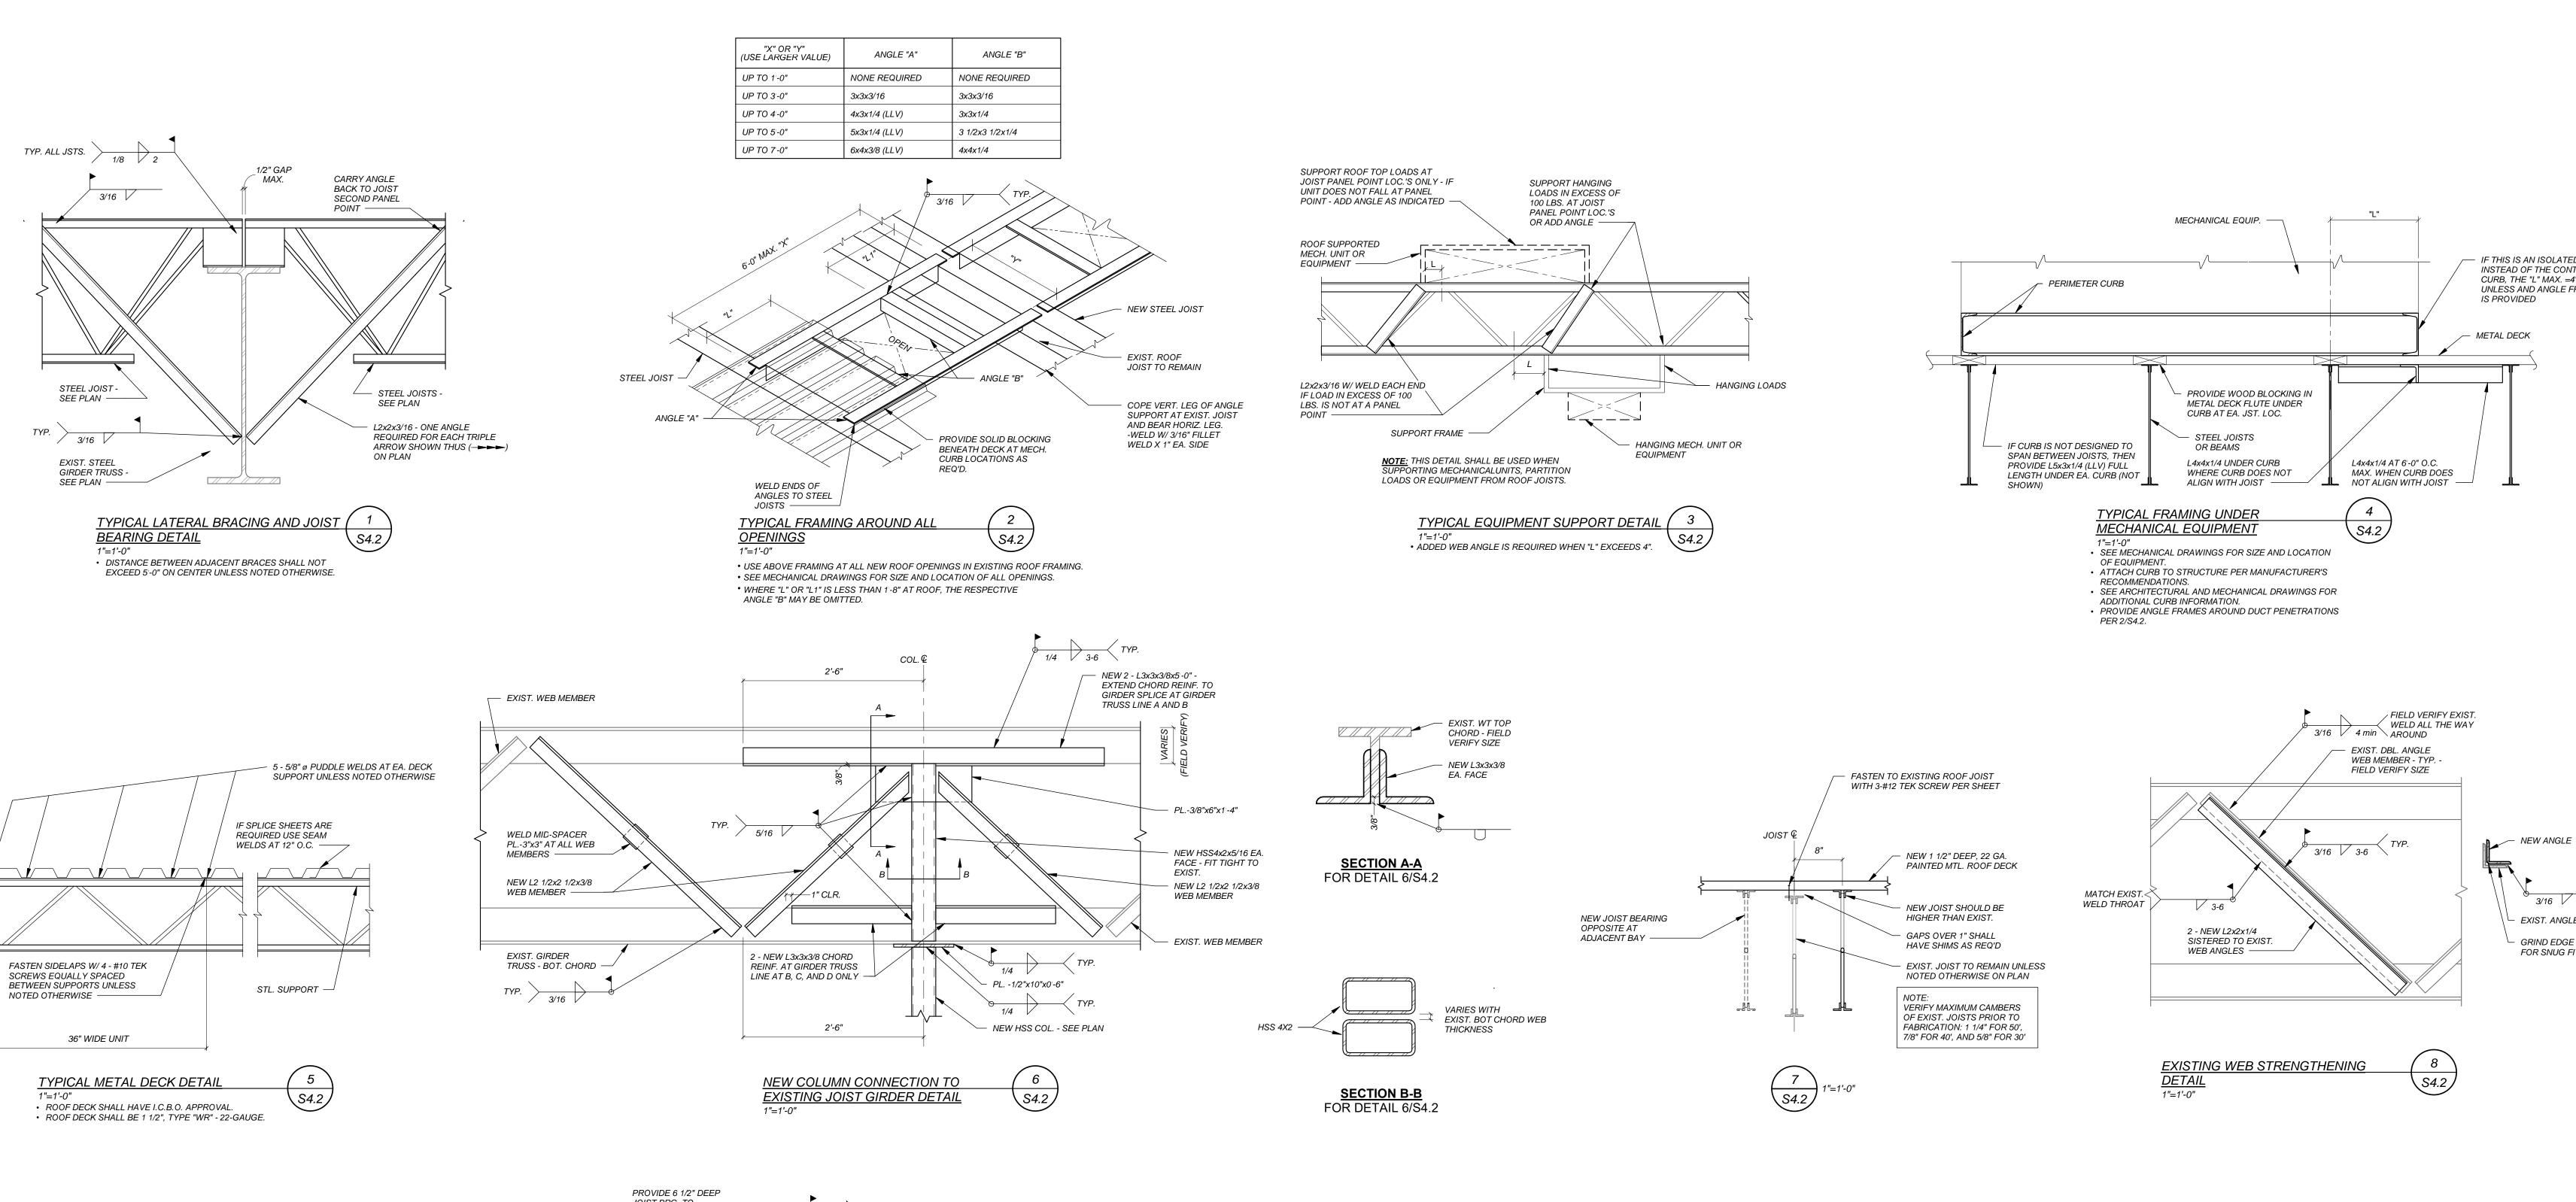

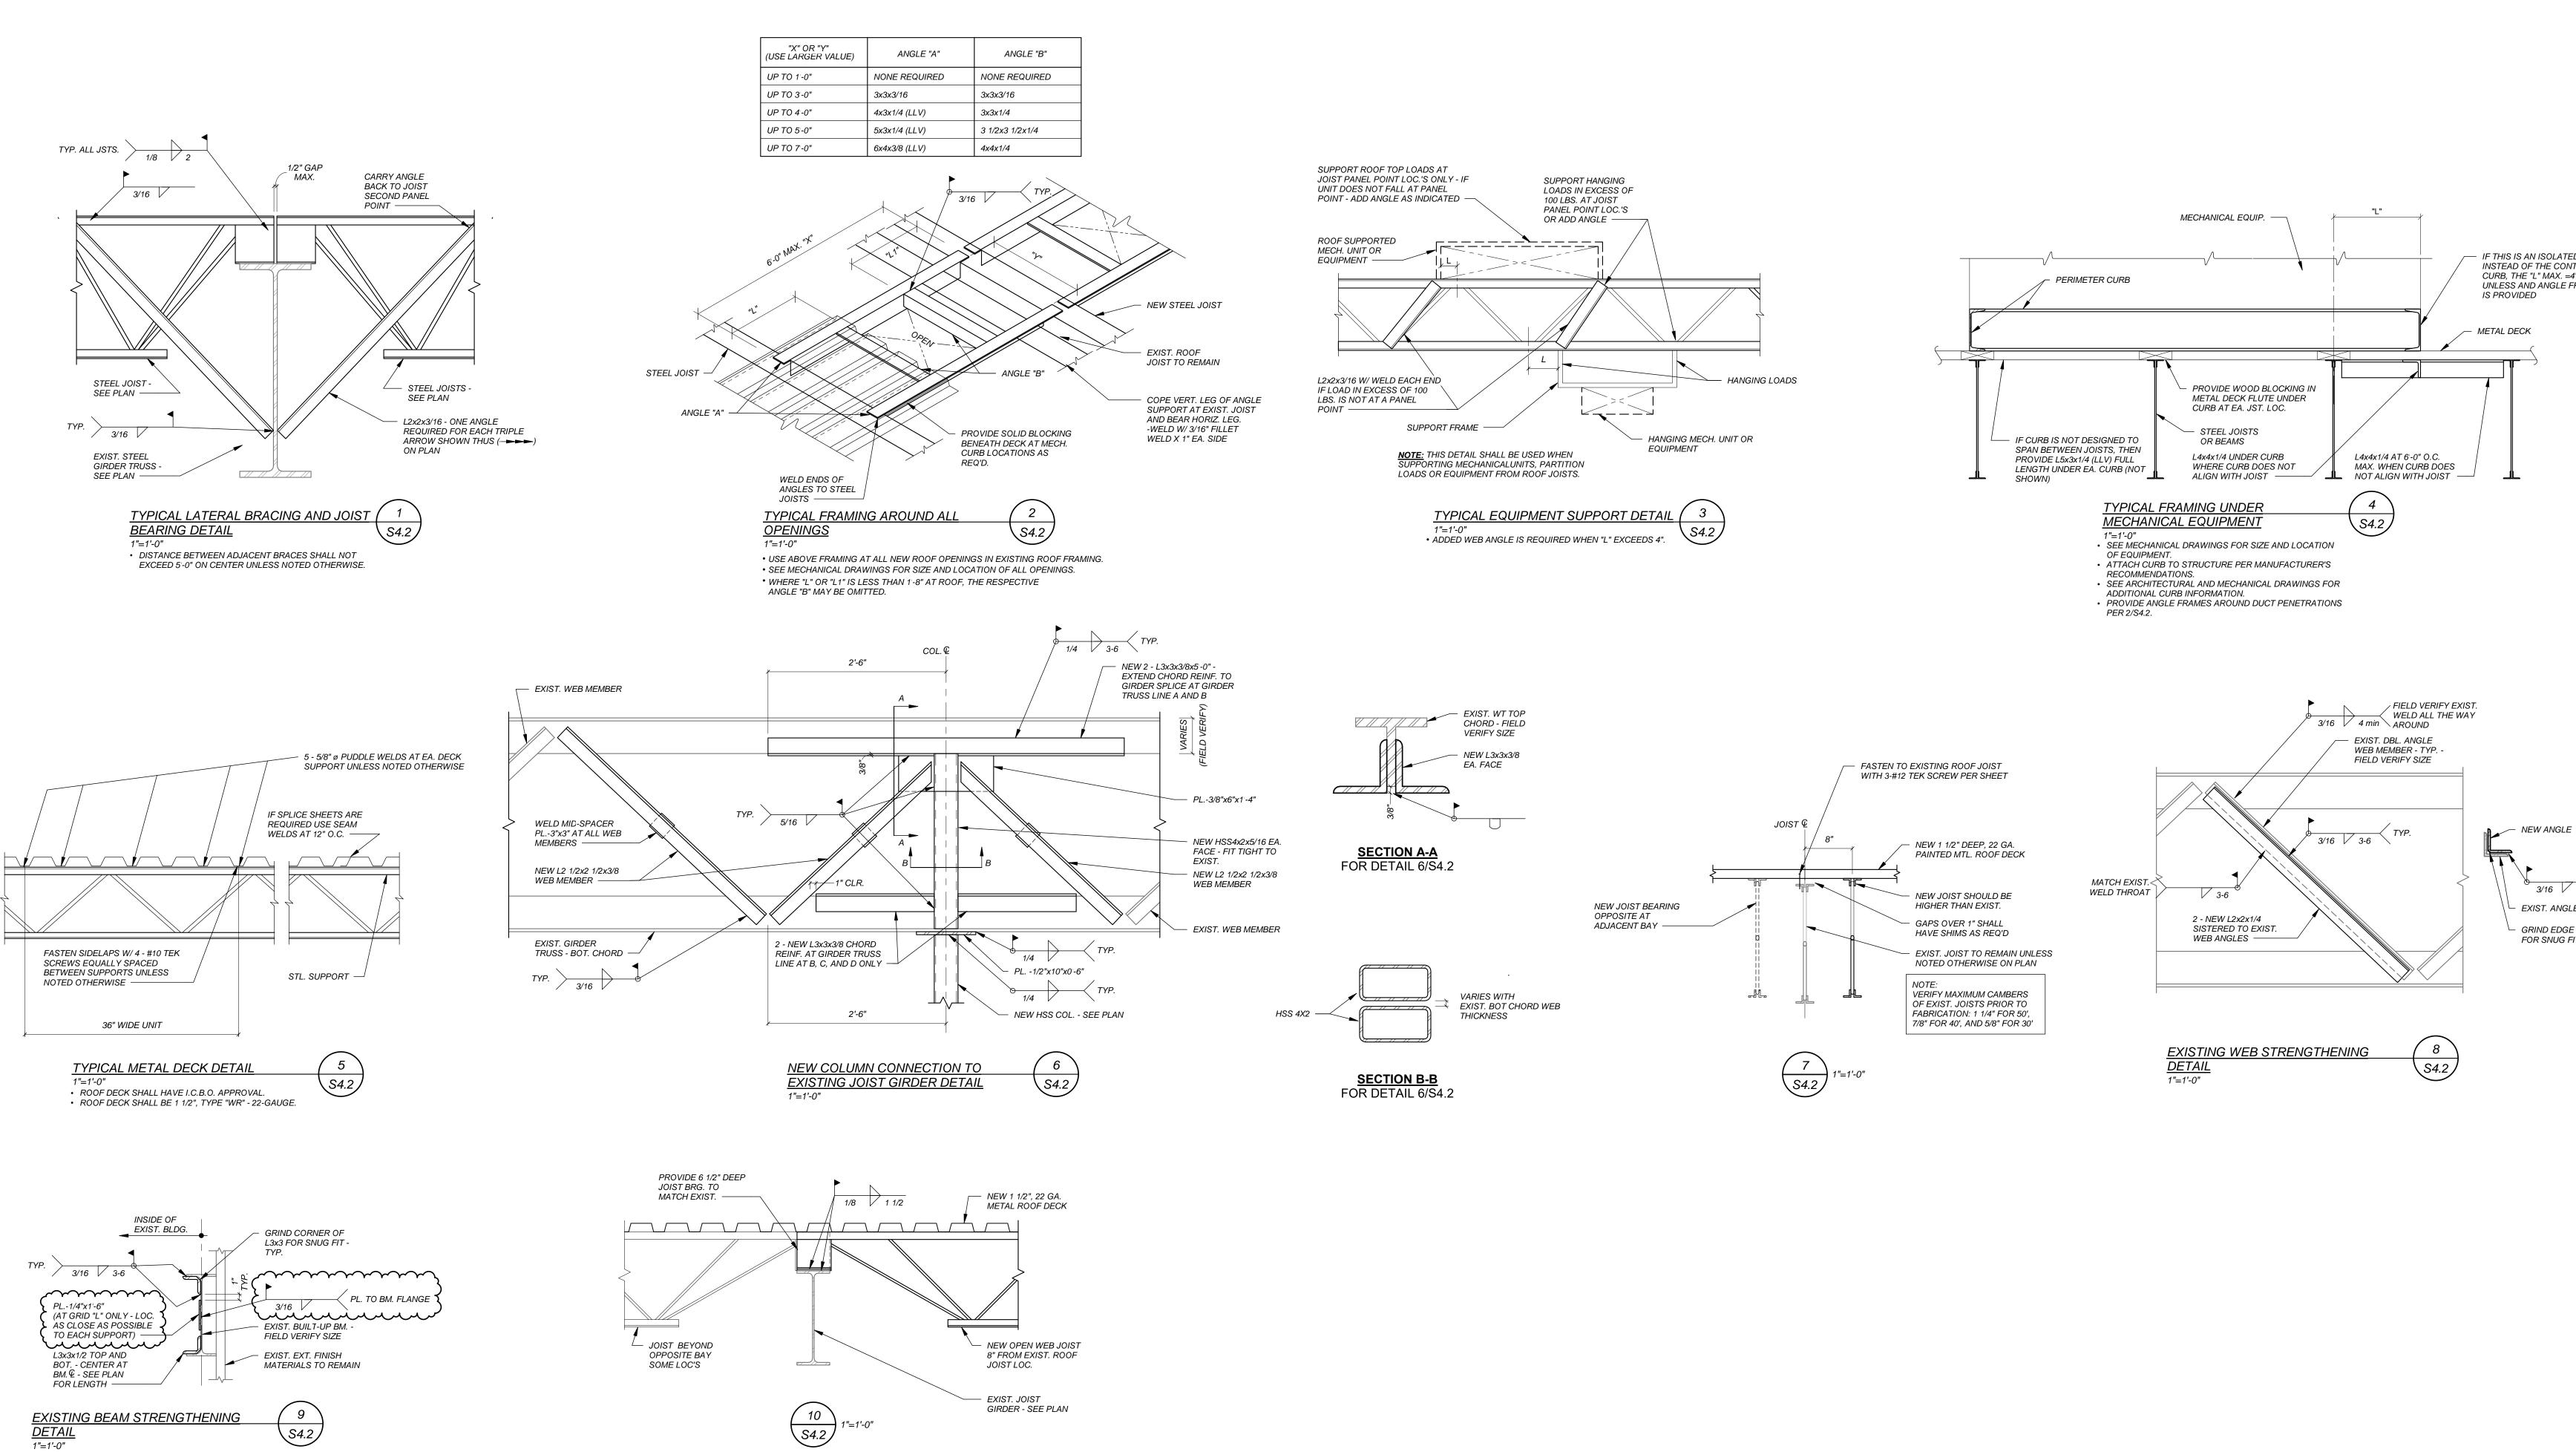

<u>EXISTING BEAM STRENGTHENING</u> <u>DETAIL</u> 1"=1'-0"

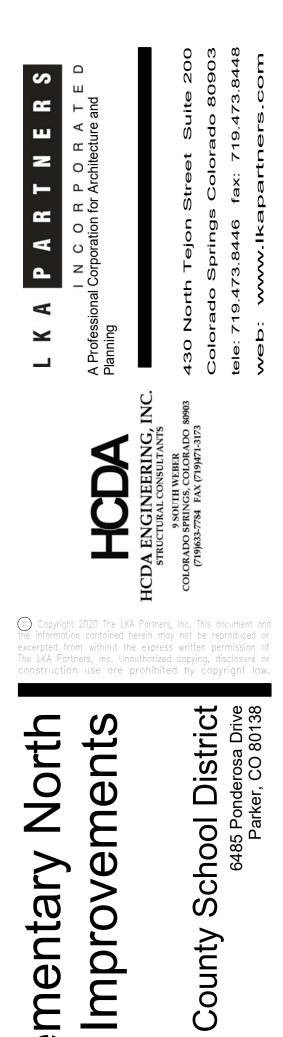

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Construction Set

Drawn:	RDB
Checked:	JAK, CBA
Issued:	12 February 2021
Revised:	y
CCD7 Rev 1	6 July 2021
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True	Plan
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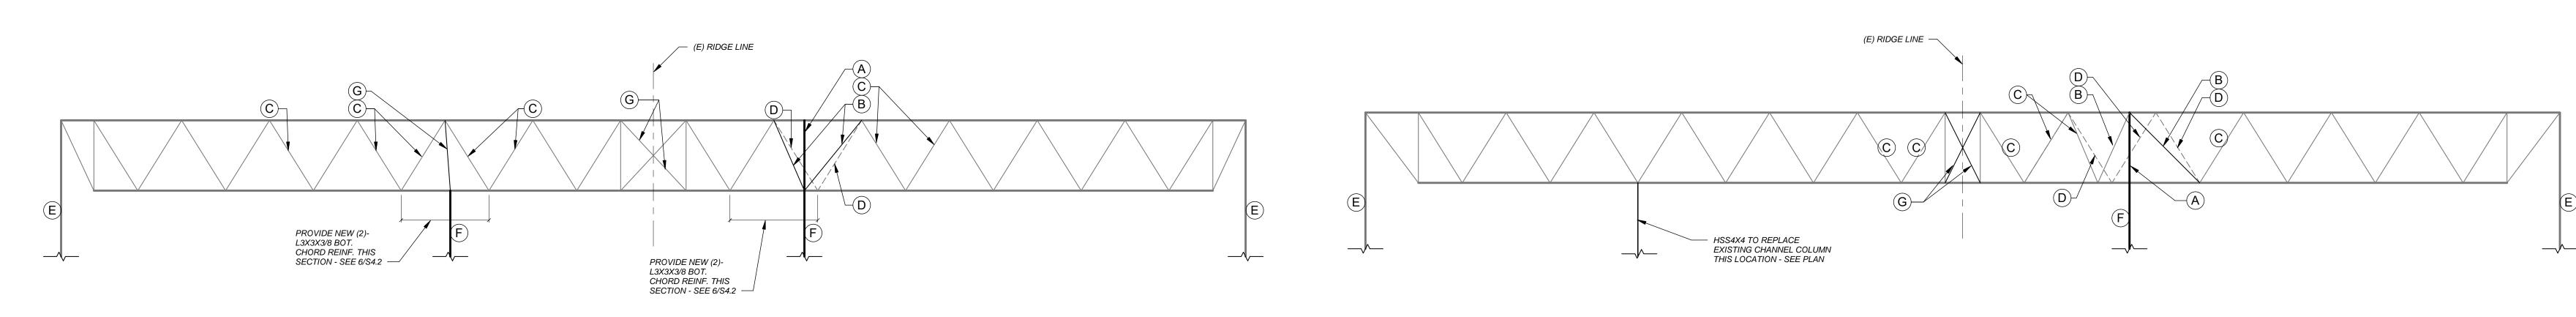
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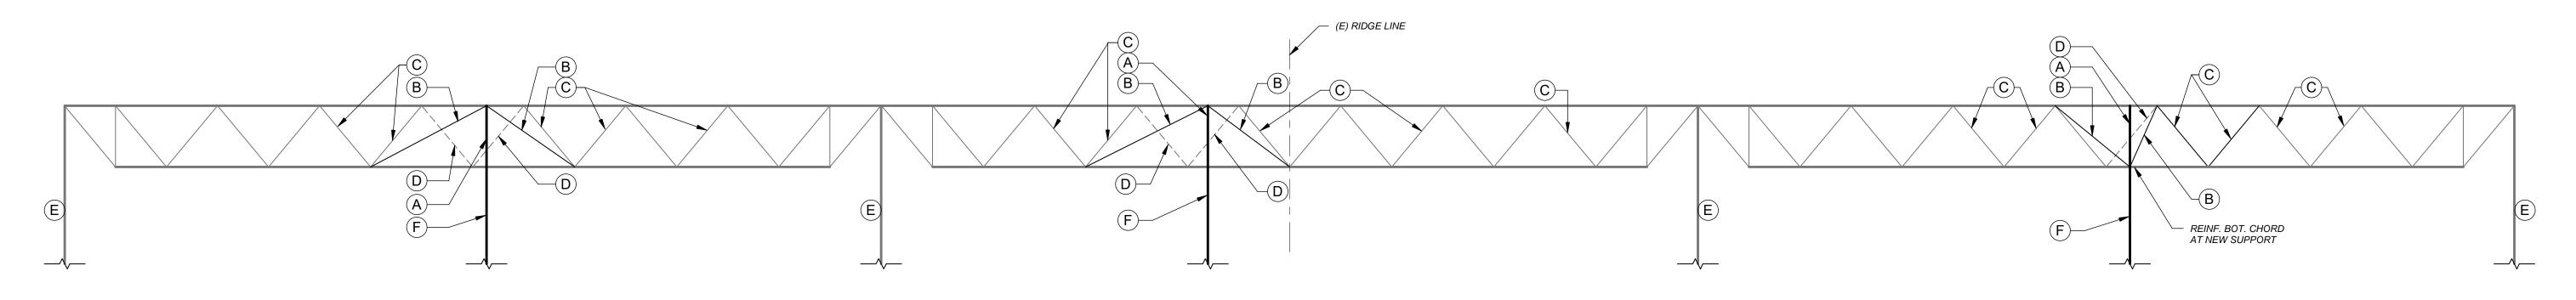
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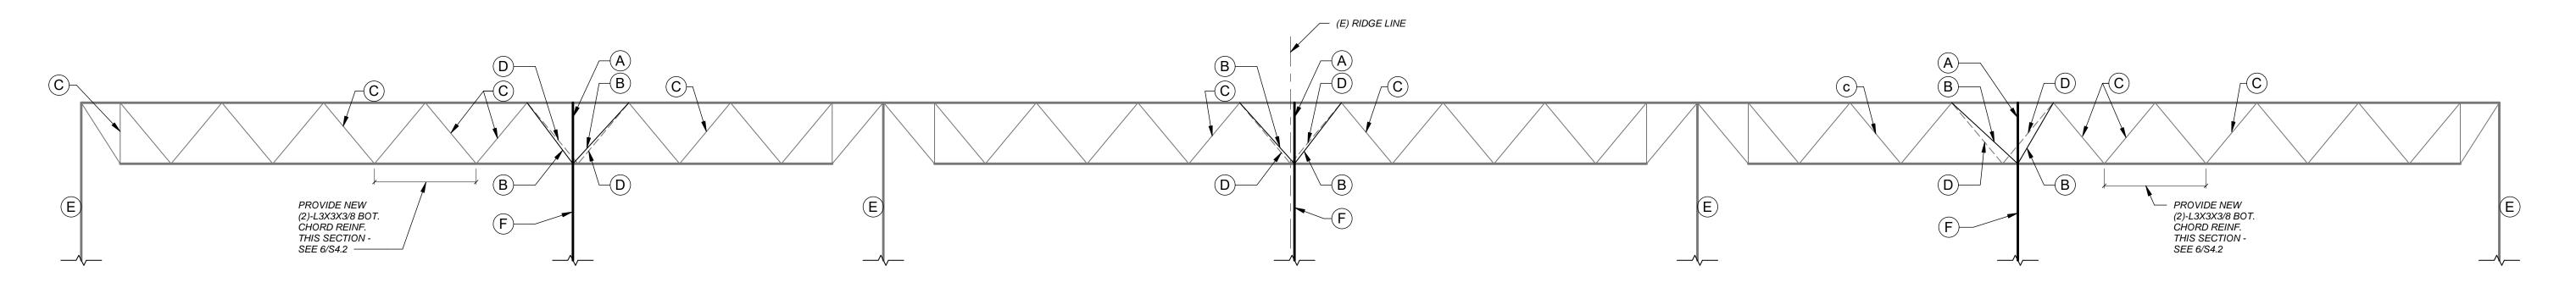
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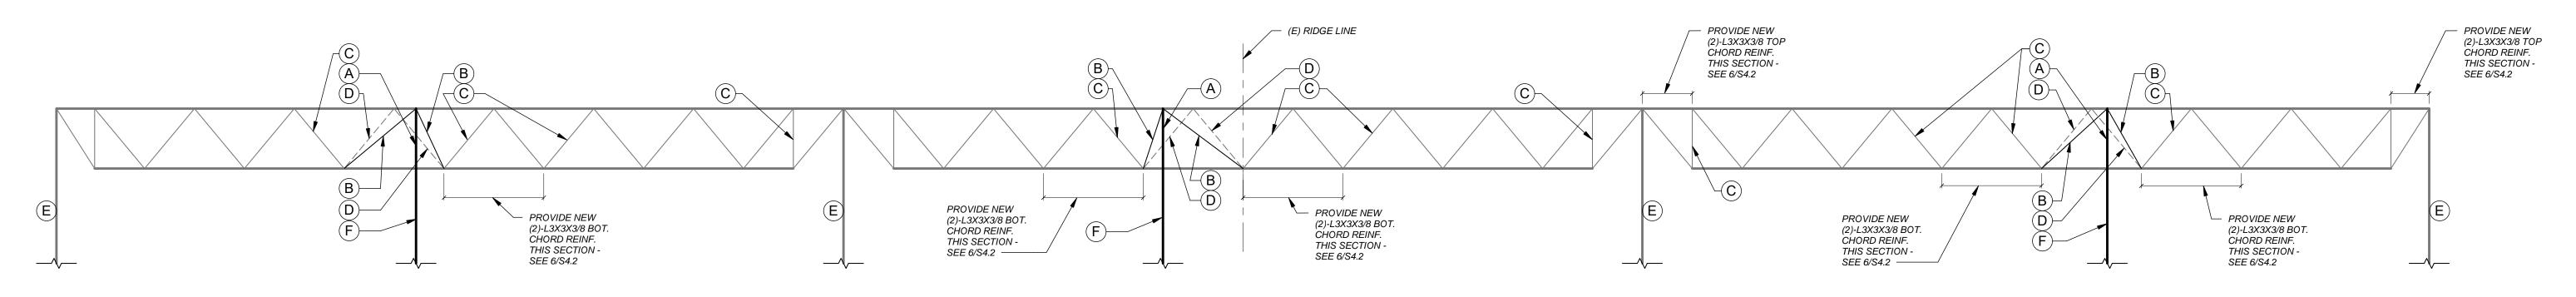
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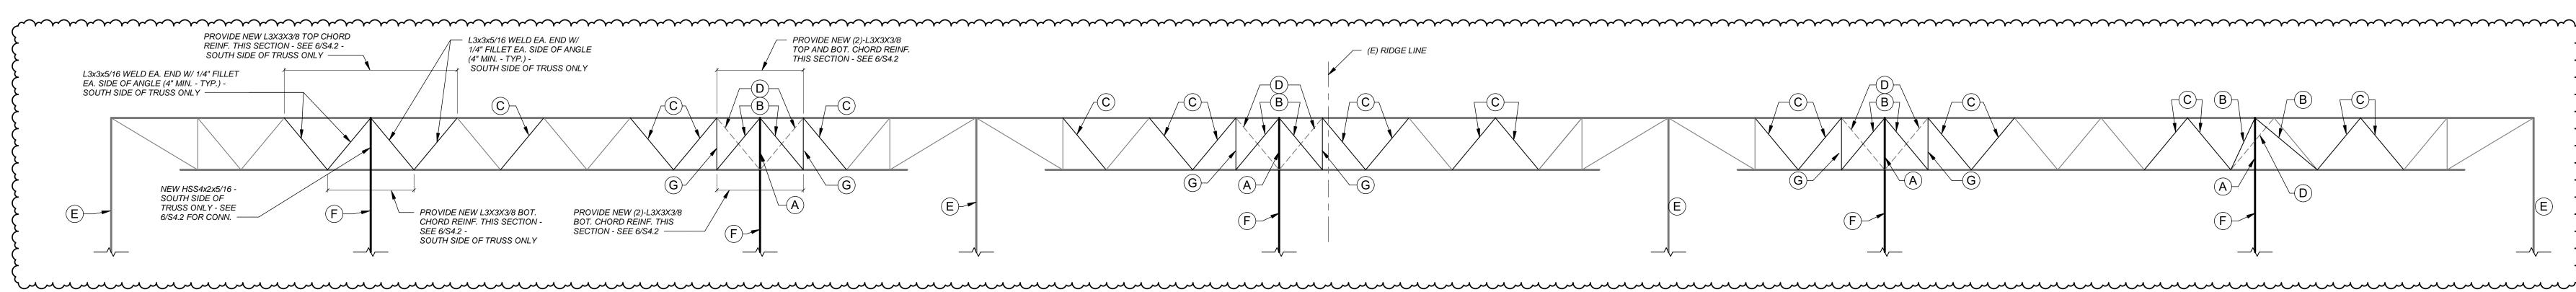


GIRDER TRUSS LINE B AND C LOOKING NORTH 1/4" = 1'-0"









GIRDER TRUSS LINE F AND H LOOKING NORTH


GIRDER TRUSS LINE G LOOKING NORTH 1/4" = 1'-0"

GIRDER TRUSS LINE J LOOKING NORTH

1/4" = 1 -0" • CONTRACTOR SHALL FIELD VERIFY ALL GIRDER TRUSS WEB MEMBER SPACING AND COLUMN LOCATIONS PRIOR TO INSTALLING NEW ROOF STRUCTURE AND RTU'S.

GIRDER TRUSS LINE K LOOKING NORTH

1/4" = 1'-0" • CONTRACTOR SHALL FIELD VERIFY ALL GIRDER TRUSS WEB MEMBER SPACING AND COLUMN LOCATIONS PRIOR TO INSTALLING NEW ROOF STRUCTURE AND RTU'S.

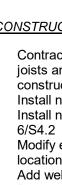

GIRDER TRUSS LINE D LOOKING NORTH

CONSTRUCTION SEQUENCE:

 Contractor shall review existing truss layout to ensure all obstructions for new joists and truss remediation have been identified and removed prior to construction and erection of new roof

 Install new foundations at new column supports. Install new column and build-up girder truss between top/bottom cords per

 Modify existing web members as indicated in truss elevations at new column locations, one side at a time. Add web member spacers throughout • Remove existing roof deck and install new foor joists. Coordinate removal and

installation with arch., mech, and electrical. See plan note sheet S4.1, coordinate area of removal to allow protection of existing finish material.

TYPICAL TRUSS REMEDIATION NOTES

A. Add new HSS4x2x5/16 and new web plate. See detail 6/S4.2.


B. Replace existing web angles with new L2 1/2X2 1/2X3/8. See detail 8/S4.2. Do one side at a time, one member at a time. Add vertical L2 1/2where

shown. C. Sister existing web angles with new L2 1/2X2 1/2X1/4. See detail 8/S4.2.

D. Web member to be removed. E. Existing column to remain.

F. New column. See plan for size. G. Add 2 new L2 1/2X2 1/2X3/8 diagonal web member.

Contractor to verify girder truss member configuration and layout prior to construction. Contact Engineer with any deviations found.

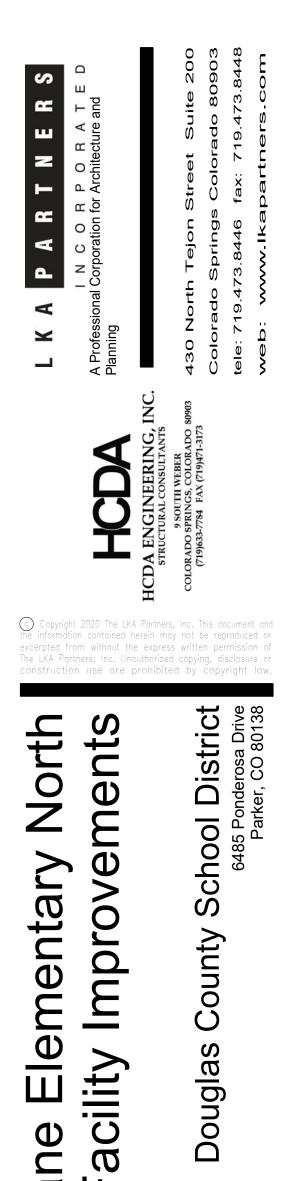

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Pine

Construction Set

